




ARCHITECTURAL DRAWINGS

FOR

3-H (G+1) DESIGN

SAMAGRA SHIKSHA

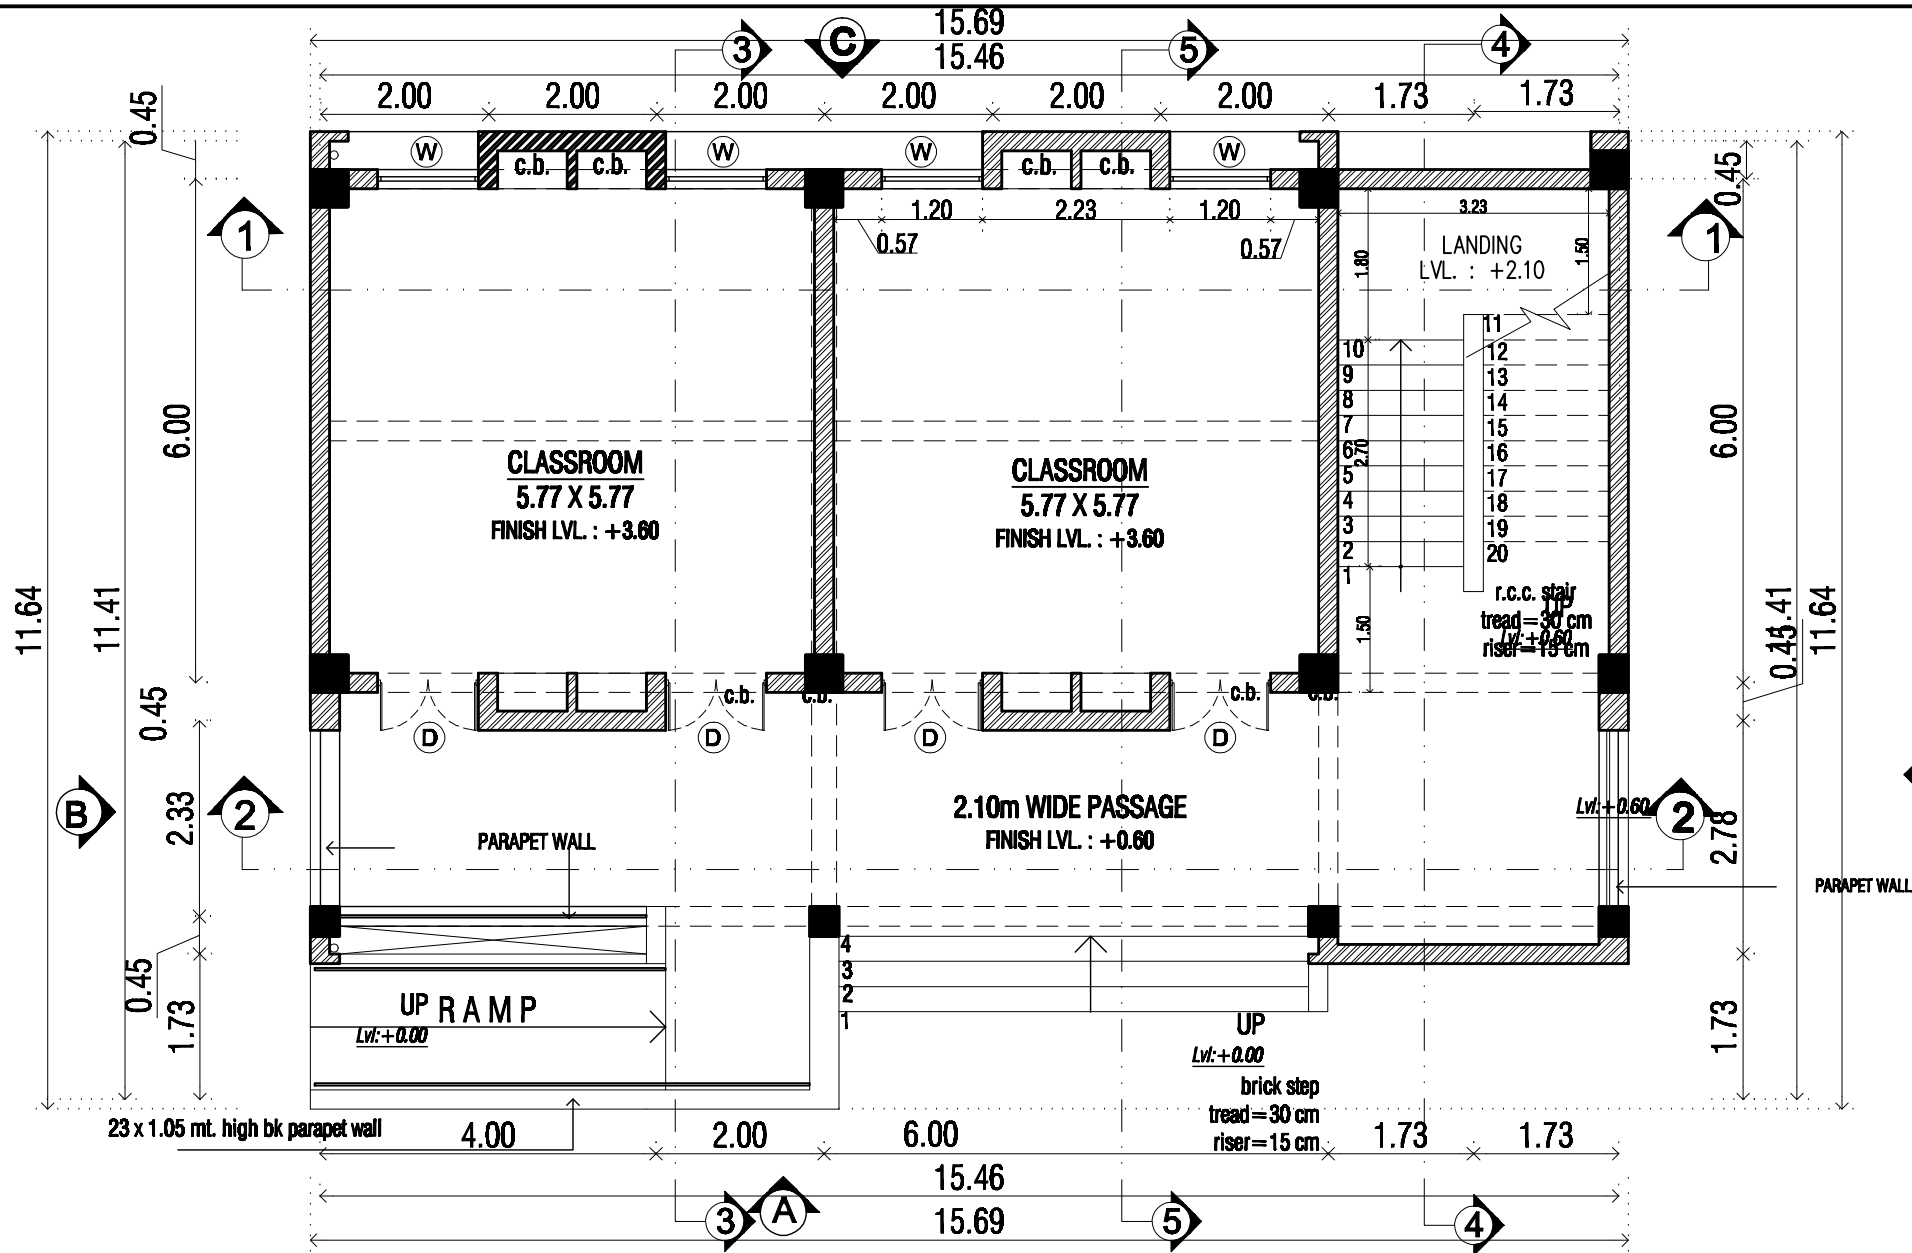


GROUND FLOOR PLAN

AREA CALCULATION :
G.F. AREA = 155.48
F.F. AREA = 99.57
CABIN AREA = 24.31
TOTAL AREA = 279.36

G.F. AREA = 155.48


DOOR - WINDOW					
TYPE	SIZE	LINTEL	SILL	LOCATION	NO.
D	1.20 X 2.40	BEAM BOTTOM	-	CLASS ROOM	06
W	1.50 X 1.50	BEAM BOTTOM	0.45	CLASS ROOM	06
DB	0.90 X 2.10	2.10	-	LADDER ROOM	01

PROJECT		
3- H - CLASSROOMS		
SSA	DRAWN BY :	DRG. NO.
	SCALE : N.T.S.	1/8
	DATE : 22/06/2020	

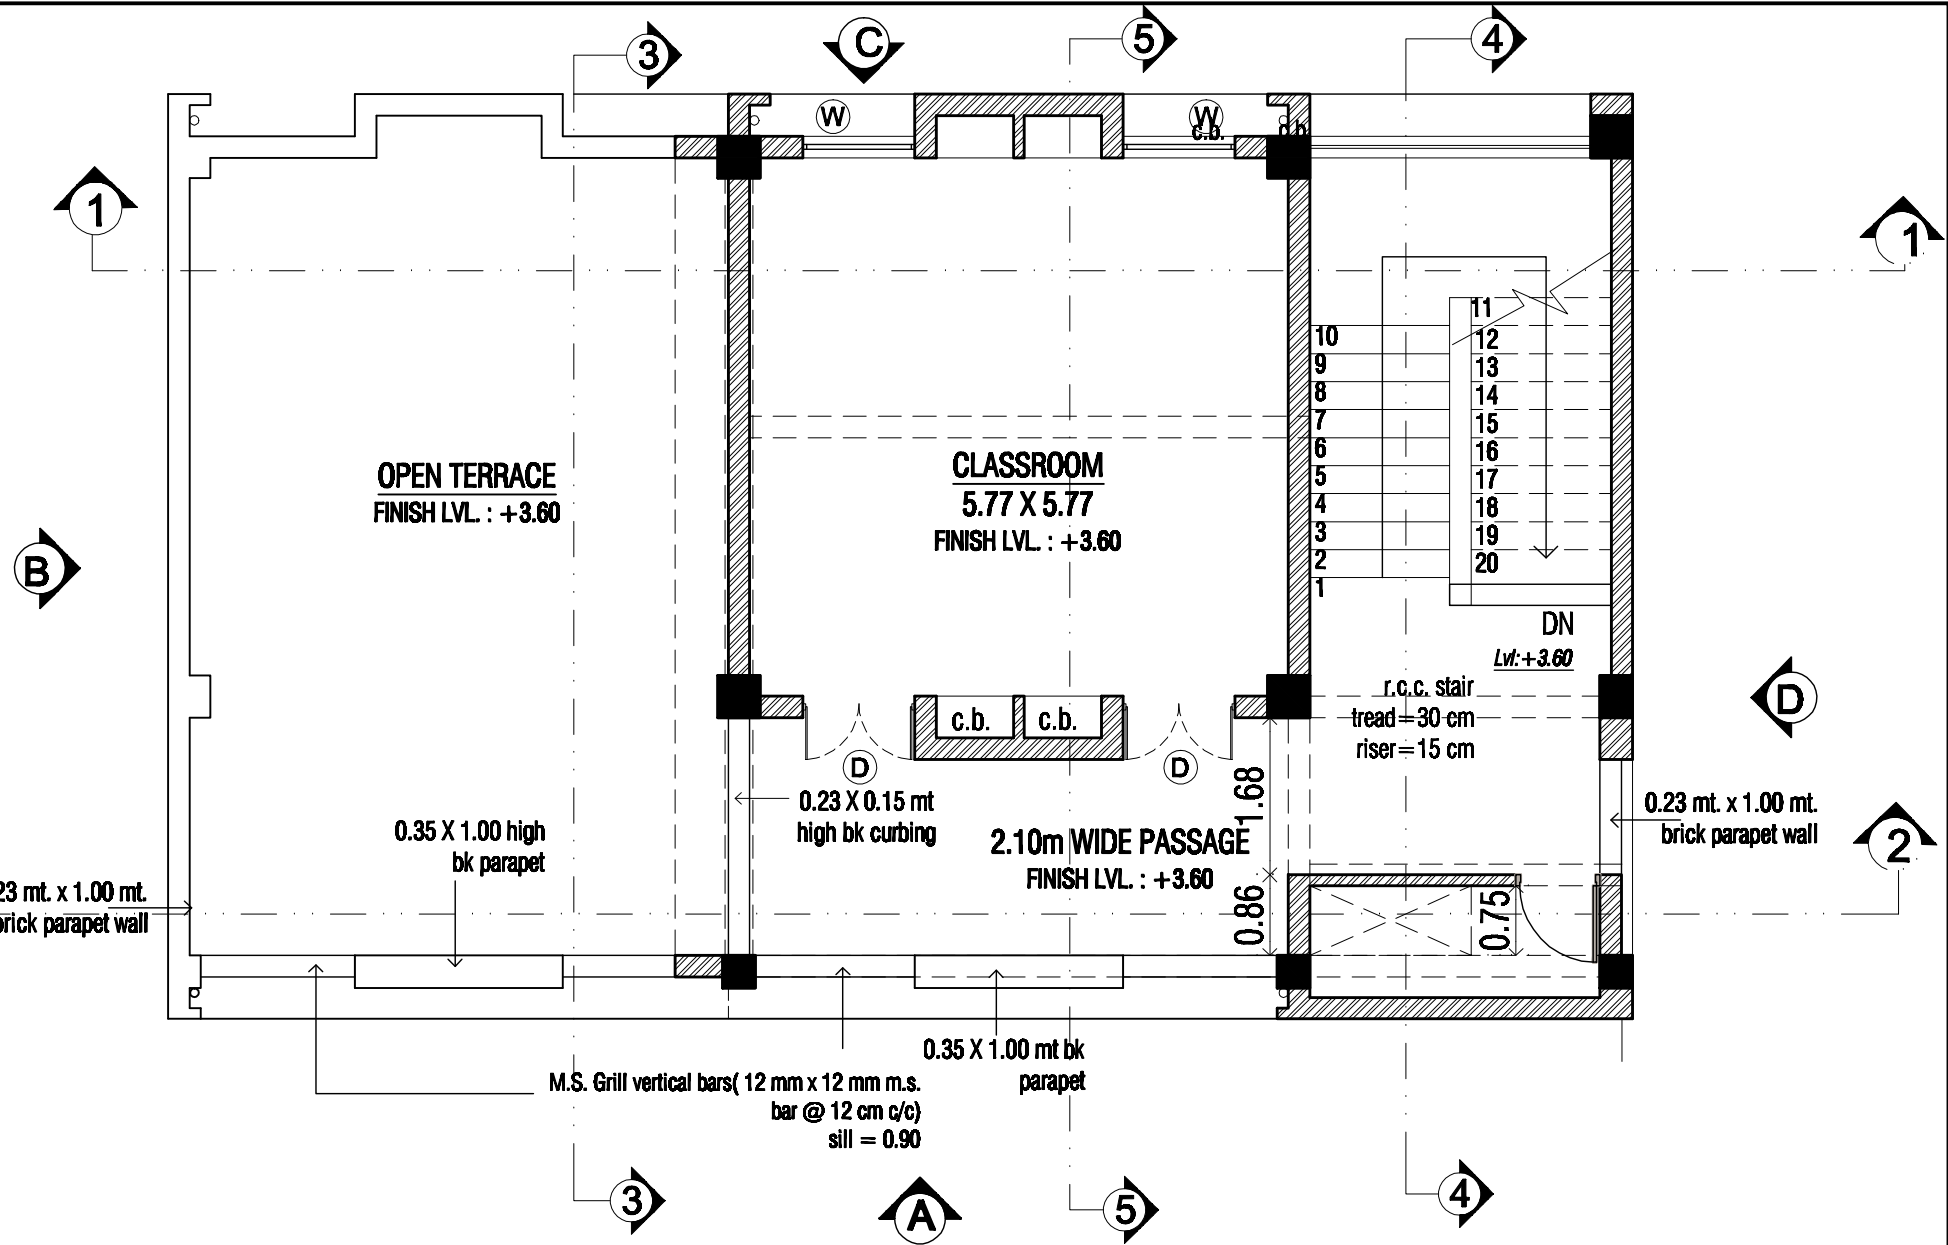

FIRST FLOOR PLAN F.F. AREA = 99.57


PROJECT		
3- H CLASSROOMS		
D.S.A	DRAWN BY :	DRG.NO.
	SCALE : N.T.S.	
	DATE : 22/01/2020	2/8

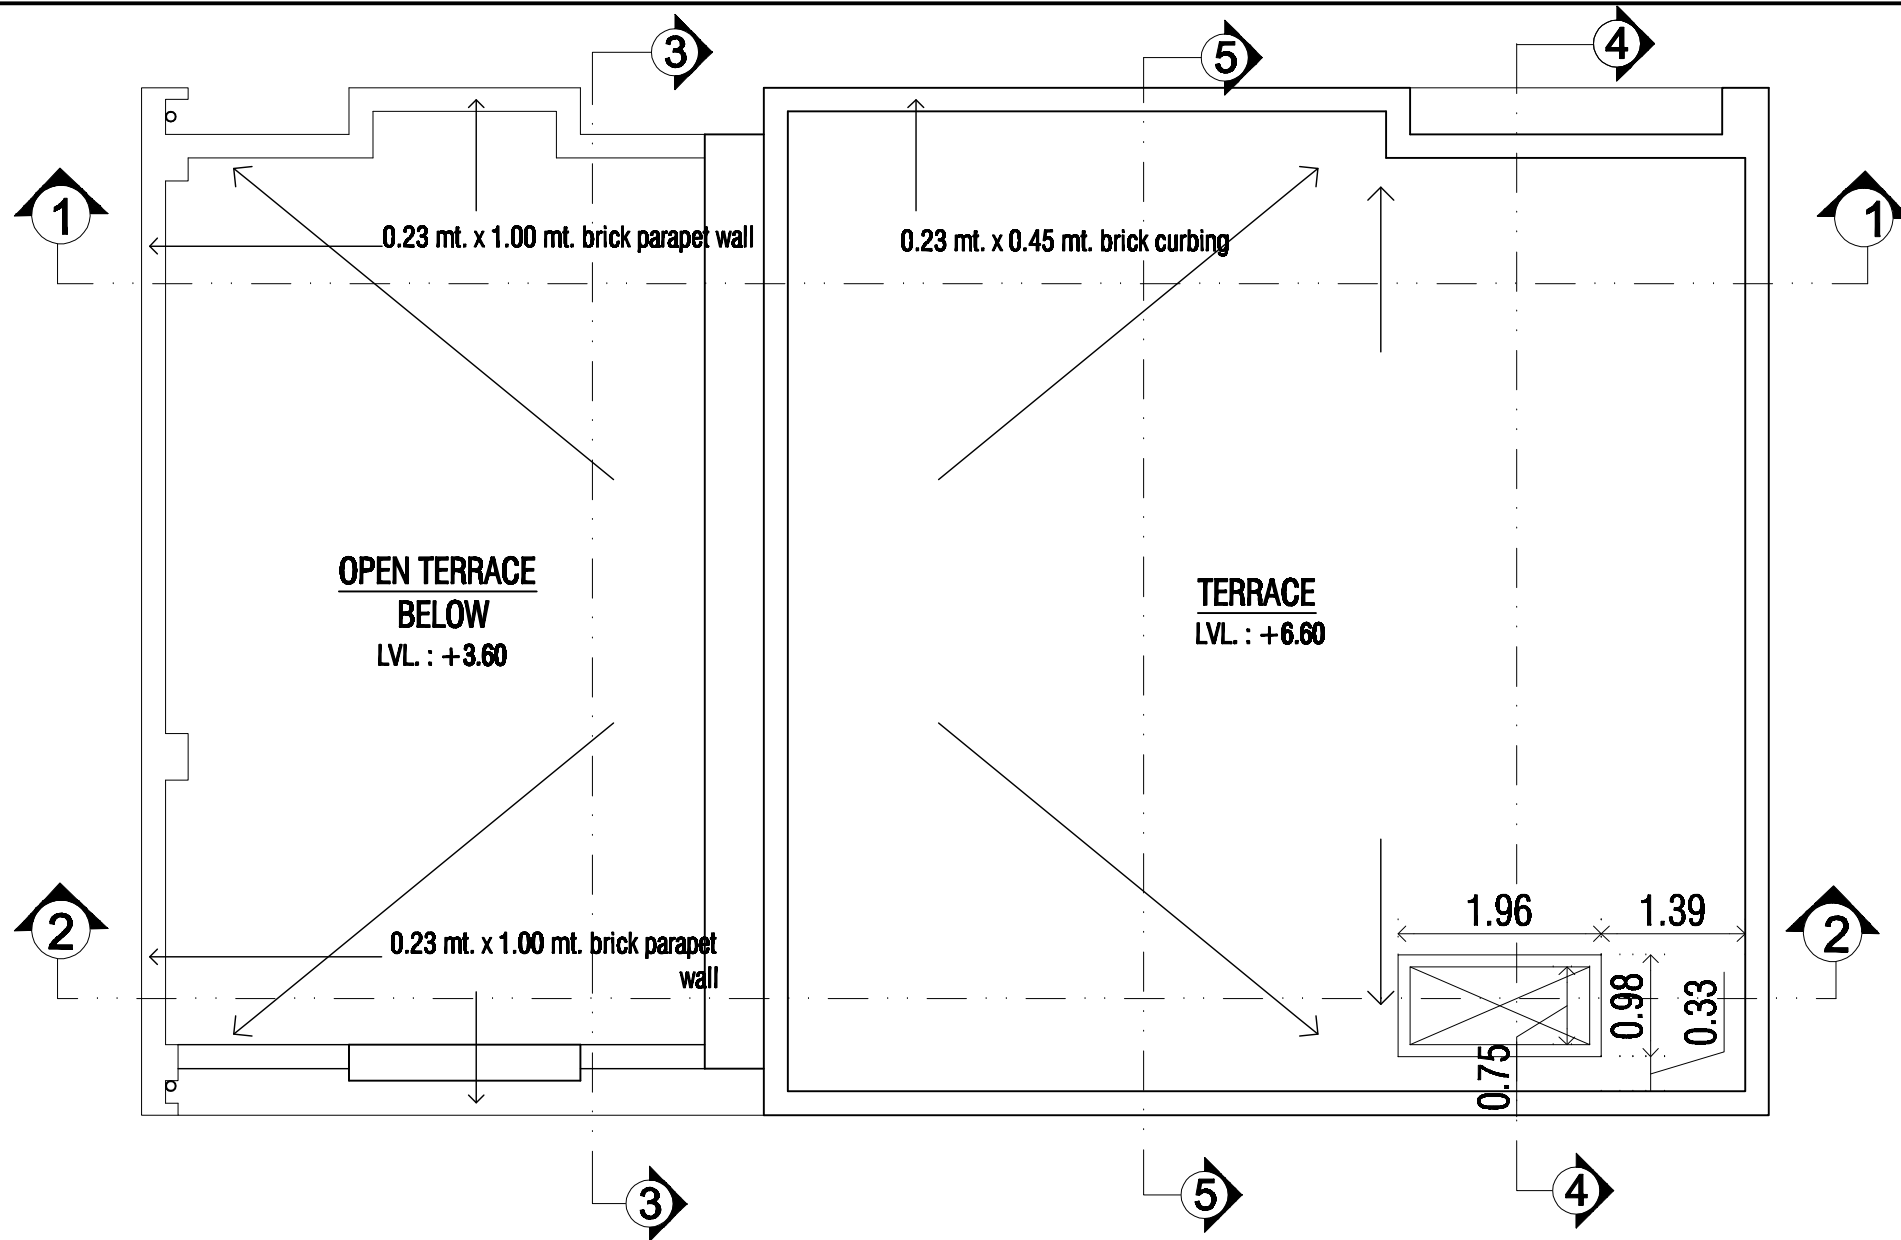


TERRACE PLAN

CABIN AREA = 24.31

PROJECT 3- H CLASSROOMS		
GSA	DRAWN BY :	DRG. NO.
	SCALE : N.T.S.	
	DATE : 20/01/2020	3/8

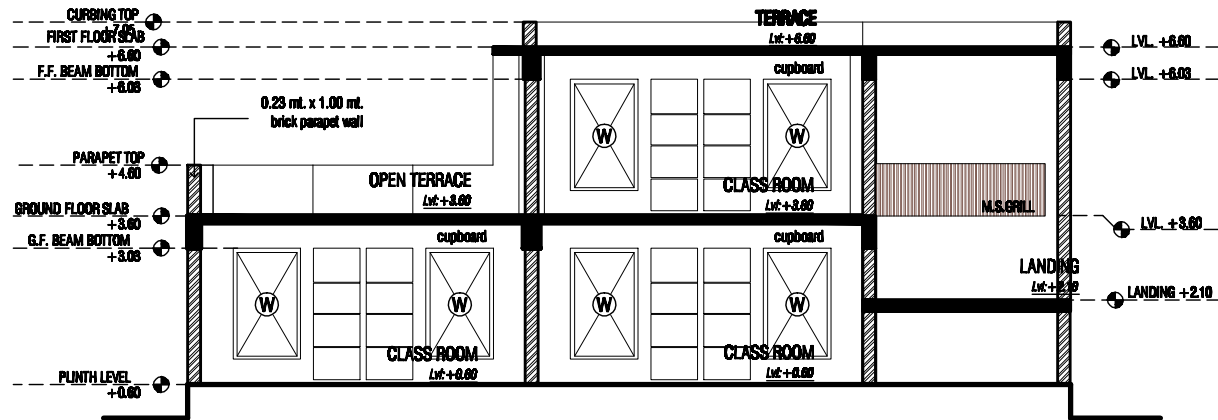


SECTION - 1-1

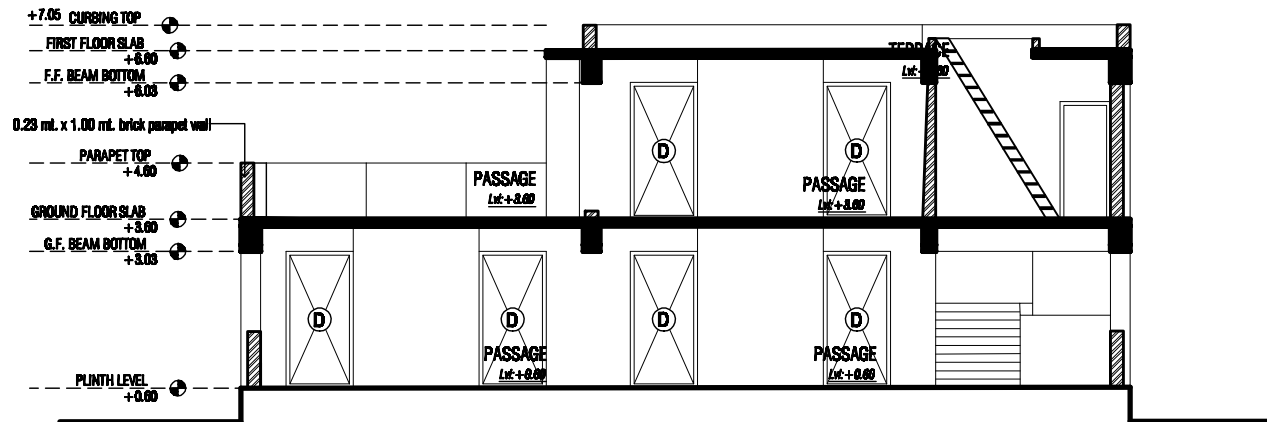


SECTION - 2-2

SECTIONS

PROJECT 3- H CLASSROOMS		
D.S.A	DRAWN BY :	DRG. NO.
	SCALE : N.T.S.	
	DATE : 22/05/2023	4/8

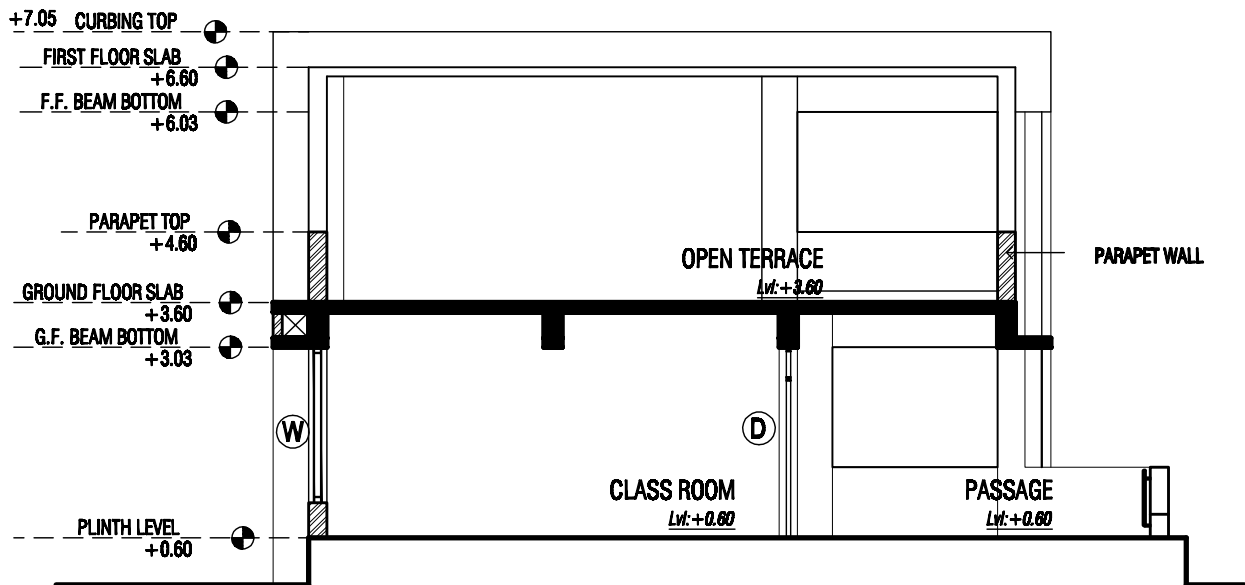

SECTION - 3-3

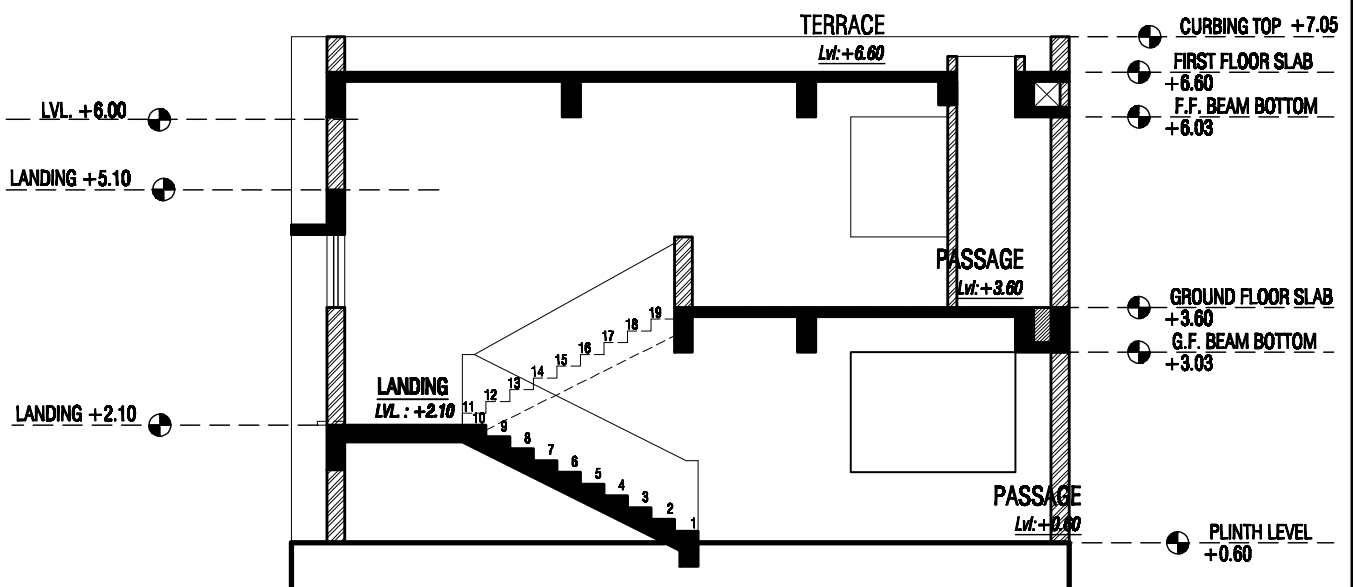

SECTION - 4-4

SECTIONS

PROJECT

3-H CLASSROOMS

S.S.A

ARCHITECT

SAUMIL GAJJAR


DRAWN BY : NIRALI PANDYA

SCALE : N.T.S.

DATE :

DWG.NO.

5/8

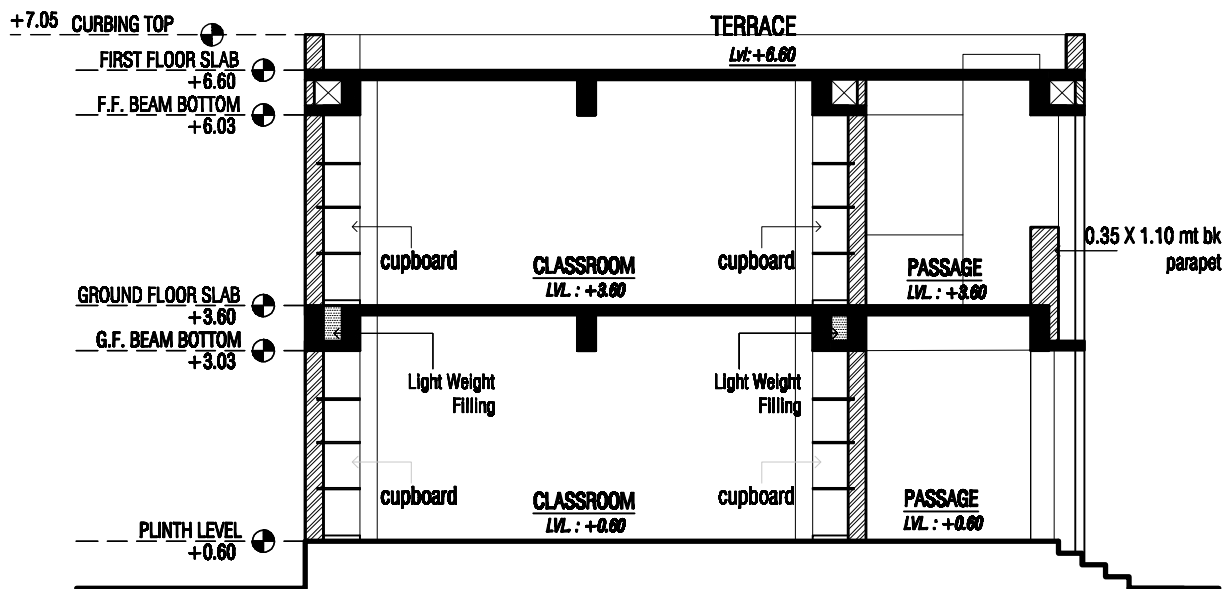

SECTIONS

PROJECT

3-H CLASSROOMS

S.S.A

ARCHITECT
SAUMIL GAJJAR


DRAWN BY : NIRALI PANDYA

SCALE : N.T.S.


DATE :

DWG.NO.

6/8

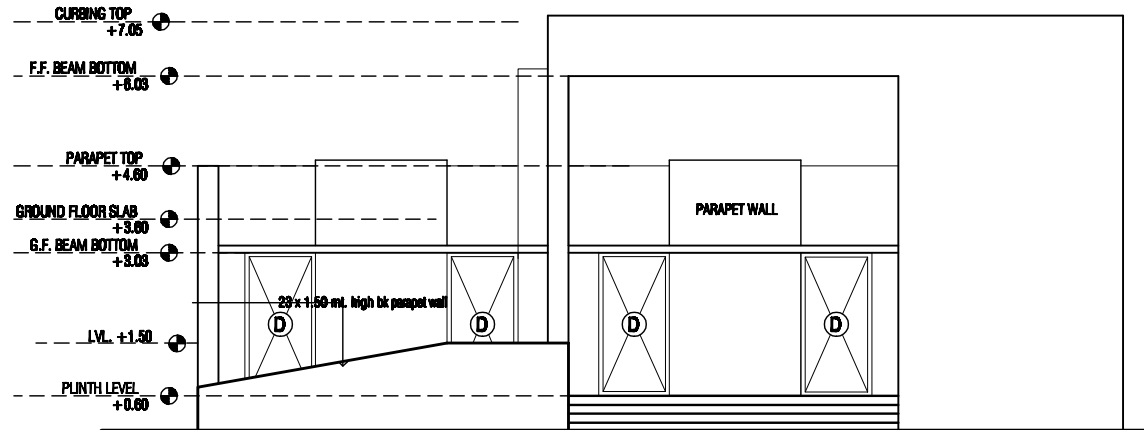



ELEVATION - A

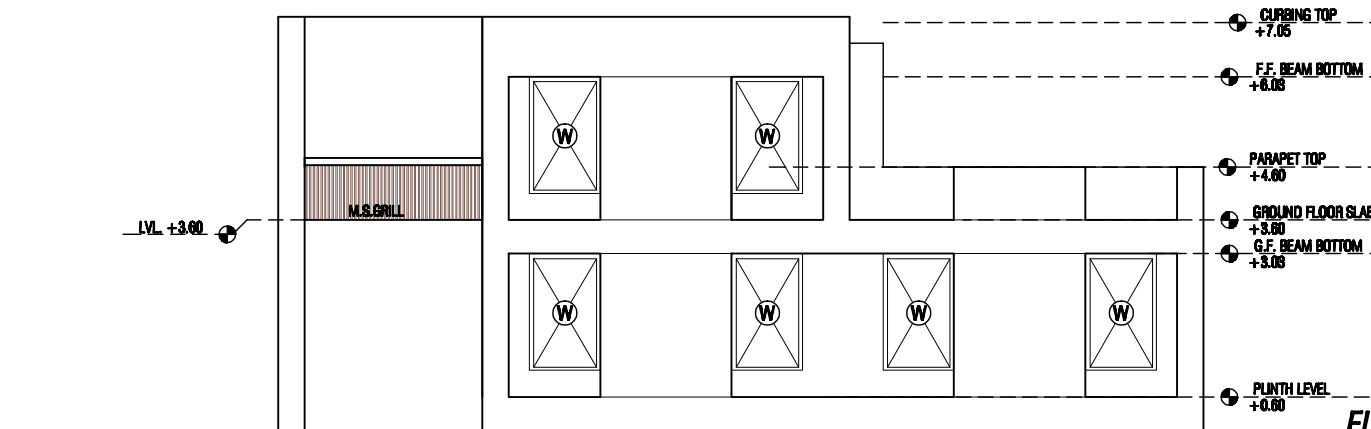

ELEVATION - C

ELEVATIONS

PROJECT		
3- H CLASSROOMS		
S.S.A	DRAWN BY :	DRG. NO.
	SCALE : N.T.S.	7/8
	DATE : 22/02/2023	

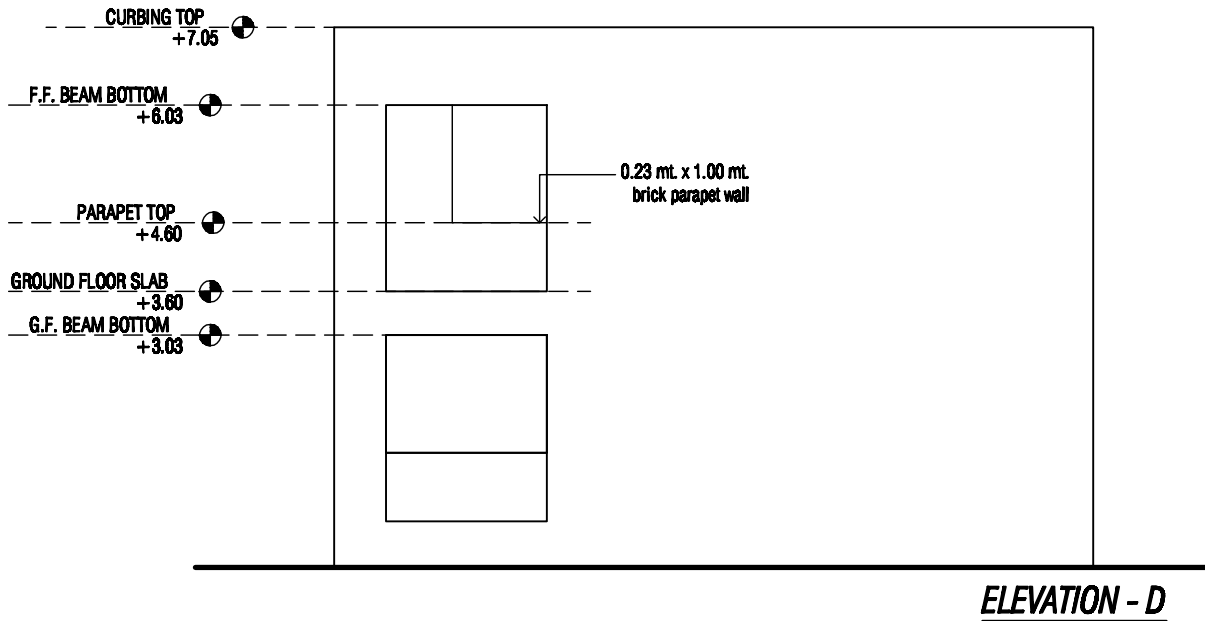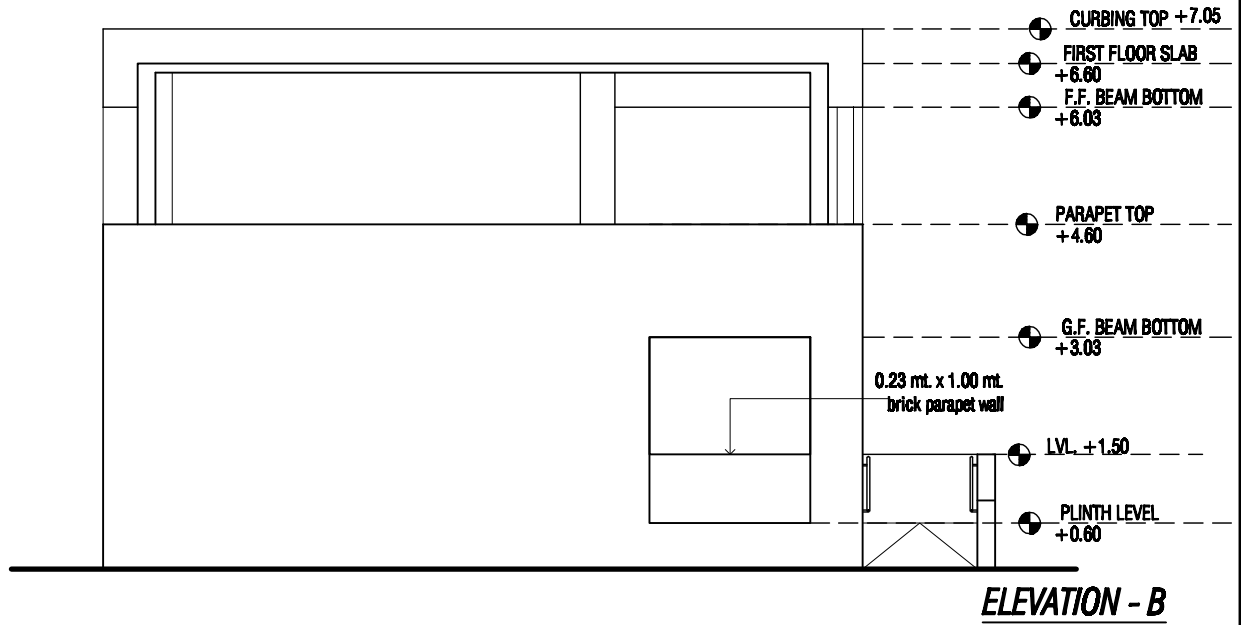

ELEVATIONS

PROJECT
3-H - CLASSROOMS

S.S.A
ARCHITECT
SAUMIL GAJJAR

DRAWN BY : NIRALI PANDYA

SCALE : N.T.S.

DATE :

DWG.NO.

8/8